
- 1. THE PLUMBER/ DRAINER SHALL INSPECT THE SITE AND CONFIRM THE EXISTING SITE STRUCTURES, SERVICES AND CONDITIONS PRIOR TO PROCEEDING. IF ANY DISCREPANCIES FOUND, CONTACT THE ENGINEER FOR DISCUSSION.
- 2. ALL WORKS TO BE CARRIED OUT IN ACCORDANCE WITH RELEVANT AUSTRALIAN STANDARDS, BUILDING CODE OF AUSTRALIA AND LOCAL GOVERNMENT'S REQUIREMENTS. IT IS THE RESPONSIBILITY OF THE PLUMBER/ DRAINER TO OBTAIN ANY APPROVALS/ PERMITS/ LICENSES ISSUED BY THE AUTHORITIES PRIOR TO PROCEEDING WITH STORMWATER WORKS.
- 3. UNLESS NOTED AS OTHERWISE, ALL DOWNPIPES TO BE \$\phi\$100 ROUND (OR 100x75) RECTANGULAR) AND FULLY SEALED; ALL STORMWATER PIPES TO BE \$\phi\$100 SEWER GRADE AND LAID AT 1% MIN. FALL. ALL MATERIALS USED IN THE WORK SHALL BE NEW AND CONFORM WITH RELEVANT AUSTRALIAN STANDARDS AND BEAR THE REQUIRED STANDARDS MARK.
- 4. LOCATION OF STORMWATER SYSTEMS, INCLUDING DOWNPIPES, PIPES, PITS AND RAINWATER TANK ARE INDICATIVE ONLY. EXACT LOCATION SHALL BE DETERMINED ON SITE TO SUIT SITE CONDITIONS.
- 5. SUB-SOIL DRAINS FOR RETAINING WALL SHALL BE INSTALLED BY THE BUILDER AND CONNECTED TO STORMWATER LINES. ALL AGG. LINES SHALL BE 100mm DIA., UNLESS NOTED OTHERWISE.
- 6. NATURAL GROUND LEVELS ALONG ALL BOUNDARIES MUST BE MAINTAINED UNALTERED. ALL RETAINING WALLS TO BE SETBACK FROM BOUNDARIES TO AVOID CONCENTRATION OF STORMWATER FLOWS.
- 7. LEVELS ARE APPROXIMATE ONLY. THE PLUMBER/ DRAINER SHALL CONFIRM THE LEVELS PRIOR TO PROCEEDING. IF ANY DISCREPANCIES FOUND, CONTACT THE ENGINEER FOR DISCUSSION.
- 8. INSPECTION AND CERTIFICATION, IF REQUIRED, SHALL BE DONE PRIOR TO BACKFILLING. ALLOW 24 HOUR NOTICE FOR THE ENGINEER TO CARRY OUT INSPECTION.
- 9. ANY DAMAGE TO SERVICES DURING CONSTRUCTION SHALL BE REPAIRED IMMEDIATELY AT THE PLUMBER/ DRAINER'S OWN EXPENSE.
- 10. THESE DRAWINGS ARE TO BE READ IN CONJUNCTION WITH: - ARCHITECTURAL PLAN BY CAD DRAFT P/L DESIGN&DRAFTING SEVICES, JOB No.5743, DATED 10-02-22

BASIX REQUIREMENTS


THIS DEVELOPMENT HAS NO COMMITMENT ON RAINWATER REUSE UNDER BASIX CERTIFICATE

OSD REQUIREMENTS

SITE AREA = 530.2m2 TOTAL IMPERVIOUS AREA = 282.41m2 IMPERVIOUS RATIO = 53% < 75% THEREFOR, OSD IS REQUIRED

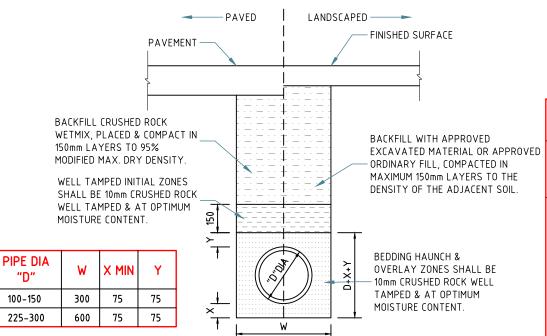

UPVC PIPE TRENCH BACKFILL TYP. DETAILS

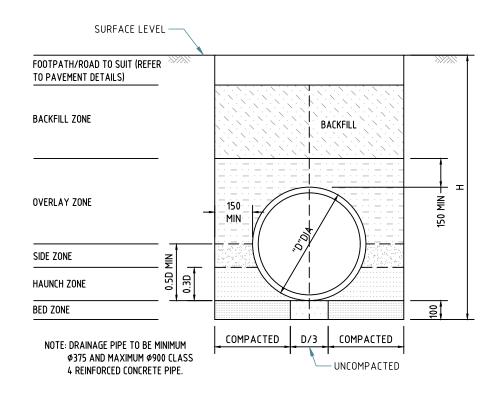

CONCRETE PIPE TRENCH BACKFILL TYP. DETAILS


SCALE 1:20



MINIMUM PIPE COVER (FROM FINISHED SURFACE TO TOP OF PIPE)

	MINIMUM COVER (mm)		
LOCATION	CAST/DUCTILE IRON GAL STEEL	OTHER AUTHORISED PRODUCTS (~)	
1. NOT SUBJECT TO VEHICULAR LOADING: A. WITHOUT PAVEMENT			
i. FOR SINGLE DWELLING	0	100	
ii. OTHER THAN SINGLE DWELLING B. WITH PAVEMENT OF	0	300	
BRICK/UNREINFORCED CONCRETE	0(~~)	50(~~)	
2. SUBJECT TO VEHICULAR LOADING: A. OTHER THAN ROAD:			
i. WITHOUT PAVEMENT ii. WITH PAVEMENT OF:	300	450	
- REIFORCED CONC. FOR HEAVY VEHICLE	0(~~#)	100(~~#)	
– BRICK/UNREINF. CONC. LIGHT VEHICLE B. ROAD	0(~~#)	75(~~#)	
i. SEALED ii. UNSEALED	300 300	500(#) 500(#)	
II. UNSEALED	000	(#)00ر	
3. SUBJECT TO CONSTRUCTION VEHICLE OR IN ENBANKMENT CONDITION	300	500(#)	

- (~) INCLUDES OVERLAY ABOVE THE TOP OF THE PIPE OF NOT LESS THAN 50mm THICK (~~) BELOW THE UNDERSIDE OF THE PAVEMENT
- (#) SUBJECT TO COMPLIANCE WITH AS1762, AS2033, AS/NZS2566.1, AS3725 OR AS4060

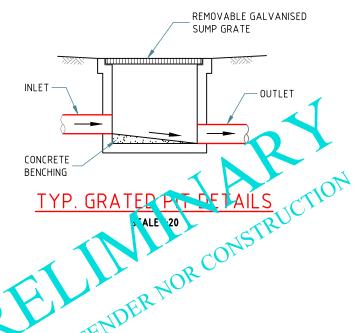

All dimensions are in millimetres. Do not scale the drawing. Use written dimensions. Dimensions must be confirmed prior to commencement. Location of services are approximate only. Dial 1100 before any excavation or demolition.

Revisions Approved: Original issue

Checked:

Designed: CH



NITMA CONSULTING PTY LTD PO Box 43, West Ryde NSW 1685 M: 0434 284 585 E: admin@nitma.com.au

W: nitma.com.au


ROJECT: NEW DWELLING

ADDRESS: 12 RIVERVIEW RD, EARLWOOD LGA: CANTERBURY BANKSTOWN COUNCIL

NOTES & STANDARD DETAILS

Project No: 5030H Issue: A Date: 17.10.2022 Sheet No:




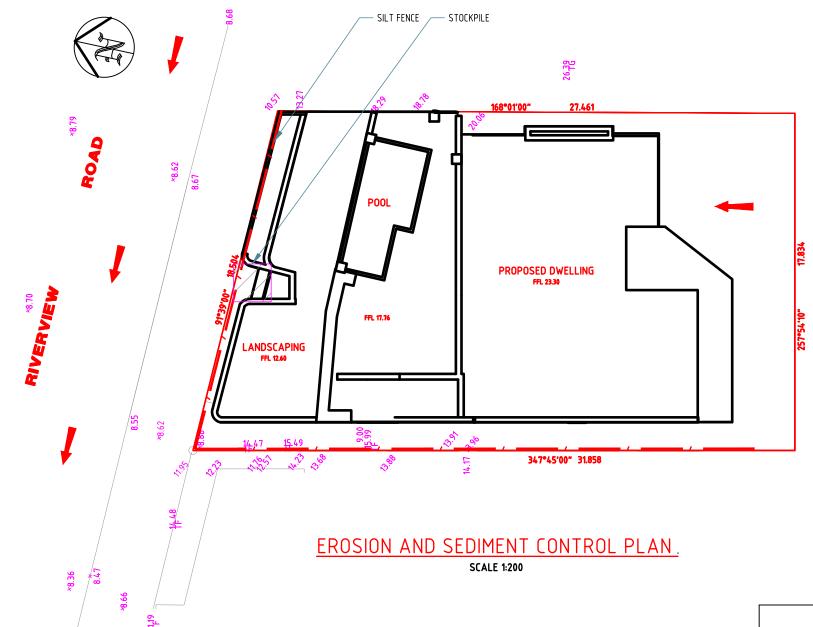

NOTES:

size: A3

- 1. ALL EROSION AND SEDIMENT CONTROL MEASURES TO BE INSPECTED AND MAINTAINED DAILY BY SITE MANAGER
- 2. MINIMISE DISTURBED AREA
- 3. ALL STOCKPILES TO BE CLEAR FROM DRAINS, GUTTERS AND FOOTPATH
- 4. DRAINAGE IS TO BE CONNECTED TO STORMWATER SYSTEM AS SOON AS POSSIBLE
- 5. ROADS AND FOOTPATH TO BE SWEPT DAILY
- 6. KERB SIDE INLET TO BE PROTECTED WITH FABRIC FILLED WITH GRAVEL

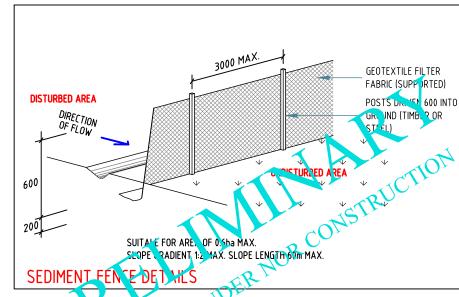

	All dimensions are in millimetres. Do not		
	scale the drawing. Use written dimensions.		
	Dimensions must be confirmed prior to		
	commencement. Location of services are		
-	approximate only. Dial 1100 before any		
	excavation or demolition.		

Revisions		Approved:	
Original issue			
Designed: CH	Checked:		
Designed. On	CHECKEU		




NITMA CONSULTING PTY LTD PO Box 43, West Ryde NSW 1685 M: 0434 284 585 E: admin@nitma.com.au W: nitma.com.au

ROJECT: NEW DWELLING A DRESS: 12 RIVERVIEW RD, EARLWOOD LGA: CANTERBURY BANKSTOWN COUNCIL

EROSION & SEDIMENT CONTROL PLAN

Project No: 5030H Issue: A Date: 17.10.2022 Sheet No: 2 of 5

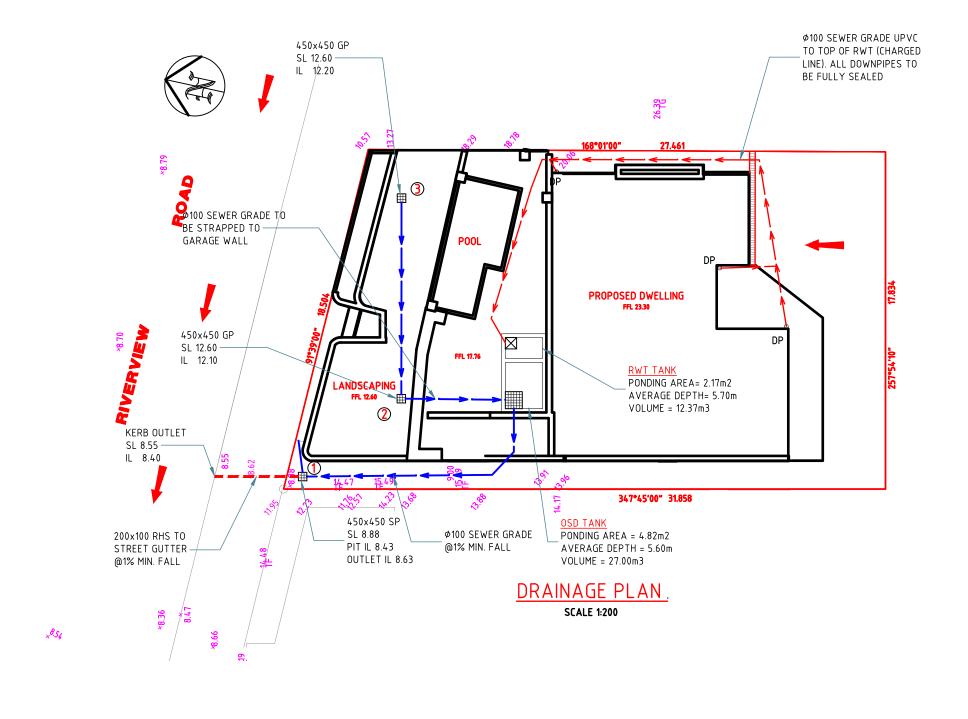

LEGEND DP DOWNPIPE GRATED PIT GΡ SP SILT ARRESTOR PIT CLEAN-OUT PIT SURF CE EVEL INVERT EVEL GRA ED BOX DRAIN ROOF- WATER PIPELINE SURFACE WATER PIPELINE CLEAN- OUT PIPELINE SURFACE RUNOFF DIRECTION EXISTING GROUND CONTOUR PROPOSED GROUND LEVEL

All dimensions are in millimetres. Do not scale the drawing. Use written dimensions. Dimensions must be confirmed prior to commencement. Location of services are approximate only. Dial 1100 before any excavation or demolition.

Revisions Approved: Original issue Designed: CH Checked: .




NITMA CONSULTING PTY LTD PO Box 43, West Ryde NSW 1685 M: 0434 284 585 E: admin@nitma.com.au
W: nitma.com.au

ROJECT: NEW DWELLING A DRESS: 12 RIVERVIEW RD, EARLWOOD LGA: CANTERBURY BANKSTOWN COUNCIL

DRAINAGE PLAN


Project No: 5030H Issue: A Date: 17.10.2022 Sheet No:

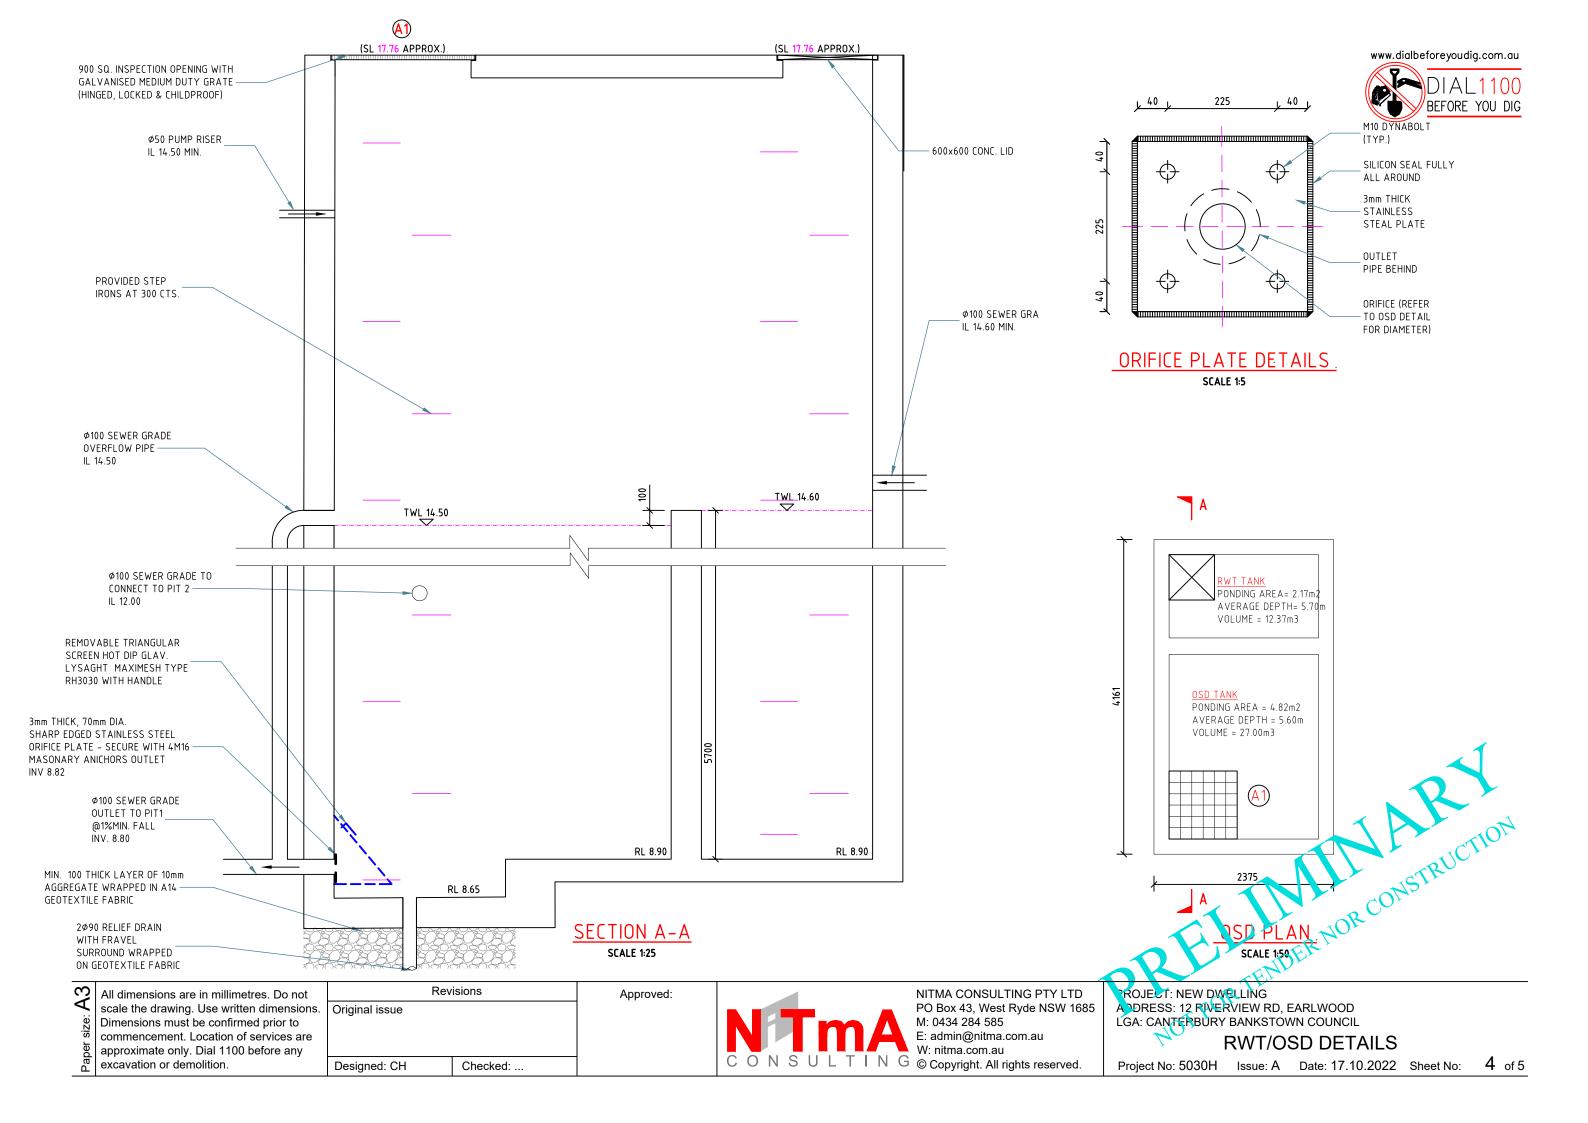




SILT ARRESTOR PIT NOTES:

- 1. MESH SCREEN IS TO BE GALVANISED LYSAGHT RH3030 MAXI MESH COVERED WITH GEOTEXTILE IN GALVANISED STEEL FRAME WITH LIFTING HANDLES ACROSS BASE.
- 2. GEOTEXTILE IS TO BE BIDIM A14, PROPEX 4550 OR SIMILAR WITH COEFFICIENT OF PERMEABILITY GREATER THAN 50E-4m/s.

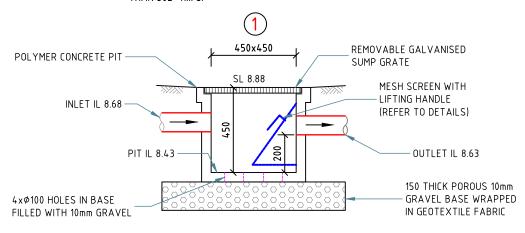

SILT ARRESTOR PIT DETAILS SCALE 1:20

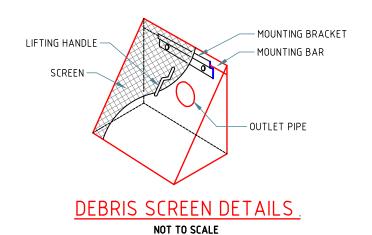

TENDER NOR CONSTRUCTION

ING
YRD

)	All dimensions are in millimetres. Do not
	scale the drawing. Use written dimensions.
)	Dimensions must be confirmed prior to
5	commencement. Location of services are
5	approximate only. Dial 1100 before any
5	excavation or demolition.

	Revisions		Approved:	
	Original issue			
-	Designed: CH	Checked:		



NITMA CONSULTING PTY LTD PO Box 43, West Ryde NSW 1685 M: 0434 284 585 E: admin@nitma.com.au W: nitma.com.au

ROJECT: NEW DWELLING ADDRESS: 12 RIVERVIEW RD, EARLWOOD LGA: CANTERBURY BANKSTOWN COUNCIL

PIT DETAILS

Project No: 5030H Issue: A Date: 17.10.2022 Sheet No: